From: Simon Ikuseru

Sent: Monday, April 1, 2024 10:52 AM

To: Kirk Brewer < kirk.brewer@nbse.ca >
Cc: John Adebisi <

Subject: Hillsborough Rd Lot Servicing for R1 Lots

Hi Kirk,

During the public hearing for our rezoning proposal for the Hillsborough Lot, Councillor Johnson asked about the feasibility of developing single-family homes on the lot. Our engineering consultant, Fisher Engineering, has conducted an analysis and we wanted to share it with you and the Council.

The findings highlight that the estimated cost for installing the necessary services (power, water, sewer, and stormwater systems) and constructing a municipal road for a ten-lot single-family home development exceeds \$830,000 plus HST. Even with an adjustment to include up to 15 lots, developing the project under the current R1 zoning would be economically unfeasible.

Given these constraints, we affirm that our proposal for a 24-unit, 2-storey townhouse development presents a viable option to responsibly develop the lot. However, in response to community feedback and to further address our neighbours' concerns, we'll be open to adjusting the two buildings closest to the road (i.e. next to the houses on Hillsborough Road) to single-storey, bungalow townhouses. This will reduce the 2 buildings to 4 units each, and provide an appealing housing option for **seniors**, aligning with the town's demographic needs and ensuring our development is *accessible* and attractive to a broader segment of Riverview's population.

We believe this approach addresses all the concerns within our control, demonstrating our commitment to a development that is both feasible and mindful of the town's values.

Please find attached the:

- 1. Detailed **cost estimate** for the town's Engineering department's review if needed;
- 1. **Site plan** showing the impact of the proposed change with more green space due to the reduction of the needed parking spaces for the 2 buildings from 22 surface parking spots to just 8 (one spot per unit) with an extra spot in each unit's garage for a total of 2 spots per unit;
- 1. **Proposed elevation** that matches the colour and design of the 2-storey buildings to the rear. And to keep more of the tree buffer on the sides undisturbed, we're

proposing porches in front of the units instead of decks+privacy walls for these units.

Thank you,

Simon Ikuseru + John Adebisi

Simon,

I've worked out an estimate for the alternative option of the single family lots on your parcel. There are only 10 lots possible as you lose one for the retention pond.

Subtotal - WATER DISTRIBUTION SYSTEM \$177,873.33

Subtotal - SANITARY SEWER SYSTEM \$103,173.33

Subtotal - STORM SEWER SYSTEM \$193,873.33

Subtotal - STREET CONSTRUCTION \$124,655.00

Subtotal - SIDEWALK CONSTRUCTION \$31,175.00

Subtotal - POND \$19,600.00

Subtotal - STREET TREES \$11,000.00

Subtotal - ENVIRONMENTAL \$22,500.00

Subtotal - SWALES \$7,400.00

Engineering, Supervision, QC \$40,000.00

Contingency \$50,000.00

Power - \$50,000.00

Total \$831,250.00 +HST

Regards

Michael Fisher, P. Eng Fisher Engineering Ltd. 40 Fairfield Road Lower Coverdale 506-863-1991

E1J 0A2



Hillsborough Townhouses Residential- Building B

Hillsborough Road, Route 114 Riverview, NB

Schematic - Issued for Review March 28th, 2024

GENERAL REQUERIMENT

1. THE CONTRACTOR SHALL STRICTLY CONFORM WITH ALL CODES HAVING JURISDICTION IN THE CONSTRUCTION OF THIS PROJECT, INCLUDING, BUT NOT LIMITED TO: FEDERAL, LOCAL, CITY, COUNTY, BUILDING, ZONING, ELECTRICAL, MECHANICAL, FIRE, LIFE SAFETY, AND HANDICAP CODES. ALL WORK MUST BE PERFORMED BY LICENSED AND INSURED CONTRACTORS AND SUBCONTRACTORS. INSURANCE CERTIFICATES, IN WRITING, WILL BE PRESENTED TO CABREIRA DESIGN CO. PRIOR TO THE START OF CONSTRUCTION.

2. THE CONTRACTOR SHALL BE RESPONSIBLE FOR THE VERIFICATION OF ALL DIMENSIONS, EXISTING CONDITIONS, AND CODE COMPLIANCE. THE CONTRACTOR SHALL VERIFY ALL EXISTING CONDITIONS. IF THE CONTRACTOR FINDS ANY DISCREPANCIES IN THE DRAWINGS OR SPECIFICATIONS HE MUST CONTACT CABREIRA DESIGN CO. FOR VERIFICATION. CABREIRA DESIGN CO. SHALL BE NOTIFIED IN WRITING OF ANY NON-CONFORMANCES IN THE SITE PLANS OR SPECIFICATIONS. THE CONTRACTOR SHALL BE RESPONSIBLE FOR BRINGING ANY ERRORS AND OMISSIONS TO THE ATTENTION OF CABREIRA DESIGN CO. IN WRITING AND SHALL AWAIT WRITTEN INSTRUCTIONS BEFORE PROCEEDING. THE CONTRACTOR WILL BE RESPONSIBLE FOR ANY ERRORS OR OMISSIONS IF THEY FAIL TO NOTIFY CABREIRA DESIGN CO. PRIOR TO THE CONSTRUCTION AND OR FABRICATION OF WORK.

3. SCOPE: THE CONTRACTOR SHALL FURNISH AND INSTALL ALL MATERIALS AND LABOR TO COMPLETE THE WORK AS DESCRIBED ON THE DRAWINGS AND SPECIFICATIONS. CONTRACTOR'S SHALL BE RESPONSIBLE FOR ALL PERMITS, COMPLIANCE STATEMENTS, CERTIFICATE OF OCCUPANCY OR OTHER DOCUMENTATION REQUIRED.

 WORK SHALL BE PERFORMED TO THE HIGHEST LEVEL OF STANDARDS OF EACH RESPECTIVE TRADE.
 DEMOLISH AS REQUIRED AND REMOVE ALL DEBRIS FROM THE SITE.

THE CONTRACTOR SHALL KEEP THE PREMISES CLEAN AND IN A WORKMANLIKE FASHION. THE PROJECT SHALL BE READY FOR OCCUPANCY UPON THE COMPLETION OF WORK IN A "TURN-KEY" CONDITION.
 CONSTRUCTION SHALL BE BY DIMENSIONS DO NOT SCALE OFF OF

8. SHOP DRAWINGS MAY BE REQUIRED BY CABREIRA DESIGN CO. FOR ALL STRUCTURAL, MECHANICAL, ELECTRICAL, LIFE SAFETY SYSTEMS, AND SPECIALIZED CONSTRUCTION FROM THE CONTRACTOR AND/OR ALL SUBCONTRACTORS AT NO ADDITIONAL COST. SHOP DRAWINGS SHALL BE SUBMITTED TO CABREIRA DESIGN CO. FOR REVIEW AND CONFORMANCE WITH THE SYSTEMS AND THEIR INTEGRATION WITH EXISTING SYSTEMS AND CONDITIONS. WORK DONE TO LIFE SAFETY SYSTEMS MAY REQUIRE SEPARATE PERMITS. THESE SHALL BE INCLUDED IN THE BASE BID.

9. THE CONTRACTOR IS RESPONSIBLE FOR MAINTAINING THE STRUCTURAL INTEGRITY OF THE BUILDING AT ALL TIMES.

10. THE CONTRACTOR SHALL NOTIFY CABREIRA DESIGN CO. IMMEDIATELY UPON THE DISCOVERY OF ANY ENVIRONMENTALLY HAZARDOUS MATERIALS AND OR CONDITIONS.

11. THESE PLANS HAVE BEEN PRODUCED TO NATIONAL BUILDING CODE ENERGY STANDARDS. ANY ADDITIONAL STRETCH CODE COMPLIANCE SHALL BE THE RESPONSIBILITY OF THE OWNER/CONTRACTOR.

APPLICABLE BUILDING CODES NATIONAL BUILDING CODE - NBC2015

BUILDING: PART 9 - HOUSING AND SMALL BUILDINGS

ENERGY: PART 9.36 - ENERGY EFFICIENCY

FIRE: PART 9.10 - FIRE PROTECTION

ELECTRICAL: PART 9.34 - ELECTRICAL FACILITIES

MECHANICAL: PART 9.33 - HEATING AND AIR-CONDITIONING

PLUMBING: PART 9.31 - PLUMBING FACILITIES

Sheet List		
Sheet Number	Sheet Name	
0000	Cover Sheet	
A101	Main Floor	
A102	Main Floor - Expanded unit	
A103	Roof Plan	
A201	Building Elevations	

Area Schedule		
Level	Name	Area
Main Floor	Unit 1	1209 SF
Main Floor	Unit 2	1209 SF
Main Floor	Unit 3	1209 SF
Main Floor	Unit 4	1209 SF
Total		4837 SF







Hillsborough Townhouses ResidentialBuilding B

Hillsborough Road, Route 114 Riverview,

KEY PLAN

PROJECT TEAM

STAMP

ISSUE SET

Schematic - Issued for Review


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CHECKED BY	A. Cabreira
NO DESCRIPTION	BY Date

Cover Sheet

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ARCHITECTURAL

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Existing Zoning R1 - Riverview, NB **Proposed Zoning RM** Description

RM Zoning Requirements Proposed Uses Townhouses Townhouses Max. 15 units/Acre = 1.6 Acre = 6,475 m2 2.43 Acres = +/- 9,854 m2 180 m2 for each house x 24 = 4,320 m2 2.43 Acres = +/- 9,854 m2 Lot Size Lot Frontage 55.04 m / 6m 19.20 m 15m / 6m for each house Front Yard 4.5 m 10.76m and 9.66m Side Yard 3.0 m Rear Yard 5.0 m 17.88 m Lot Coverage 50% (4.926.79 m2) 17.80% (1,754 m2) Units 20 units Building Height 10m 10m 44 Parking 1 for each unit (24) 35% (3.448,75 m2) 18.71% (1,844 m2) 2.75 m x 5.50 m (90 degrees)

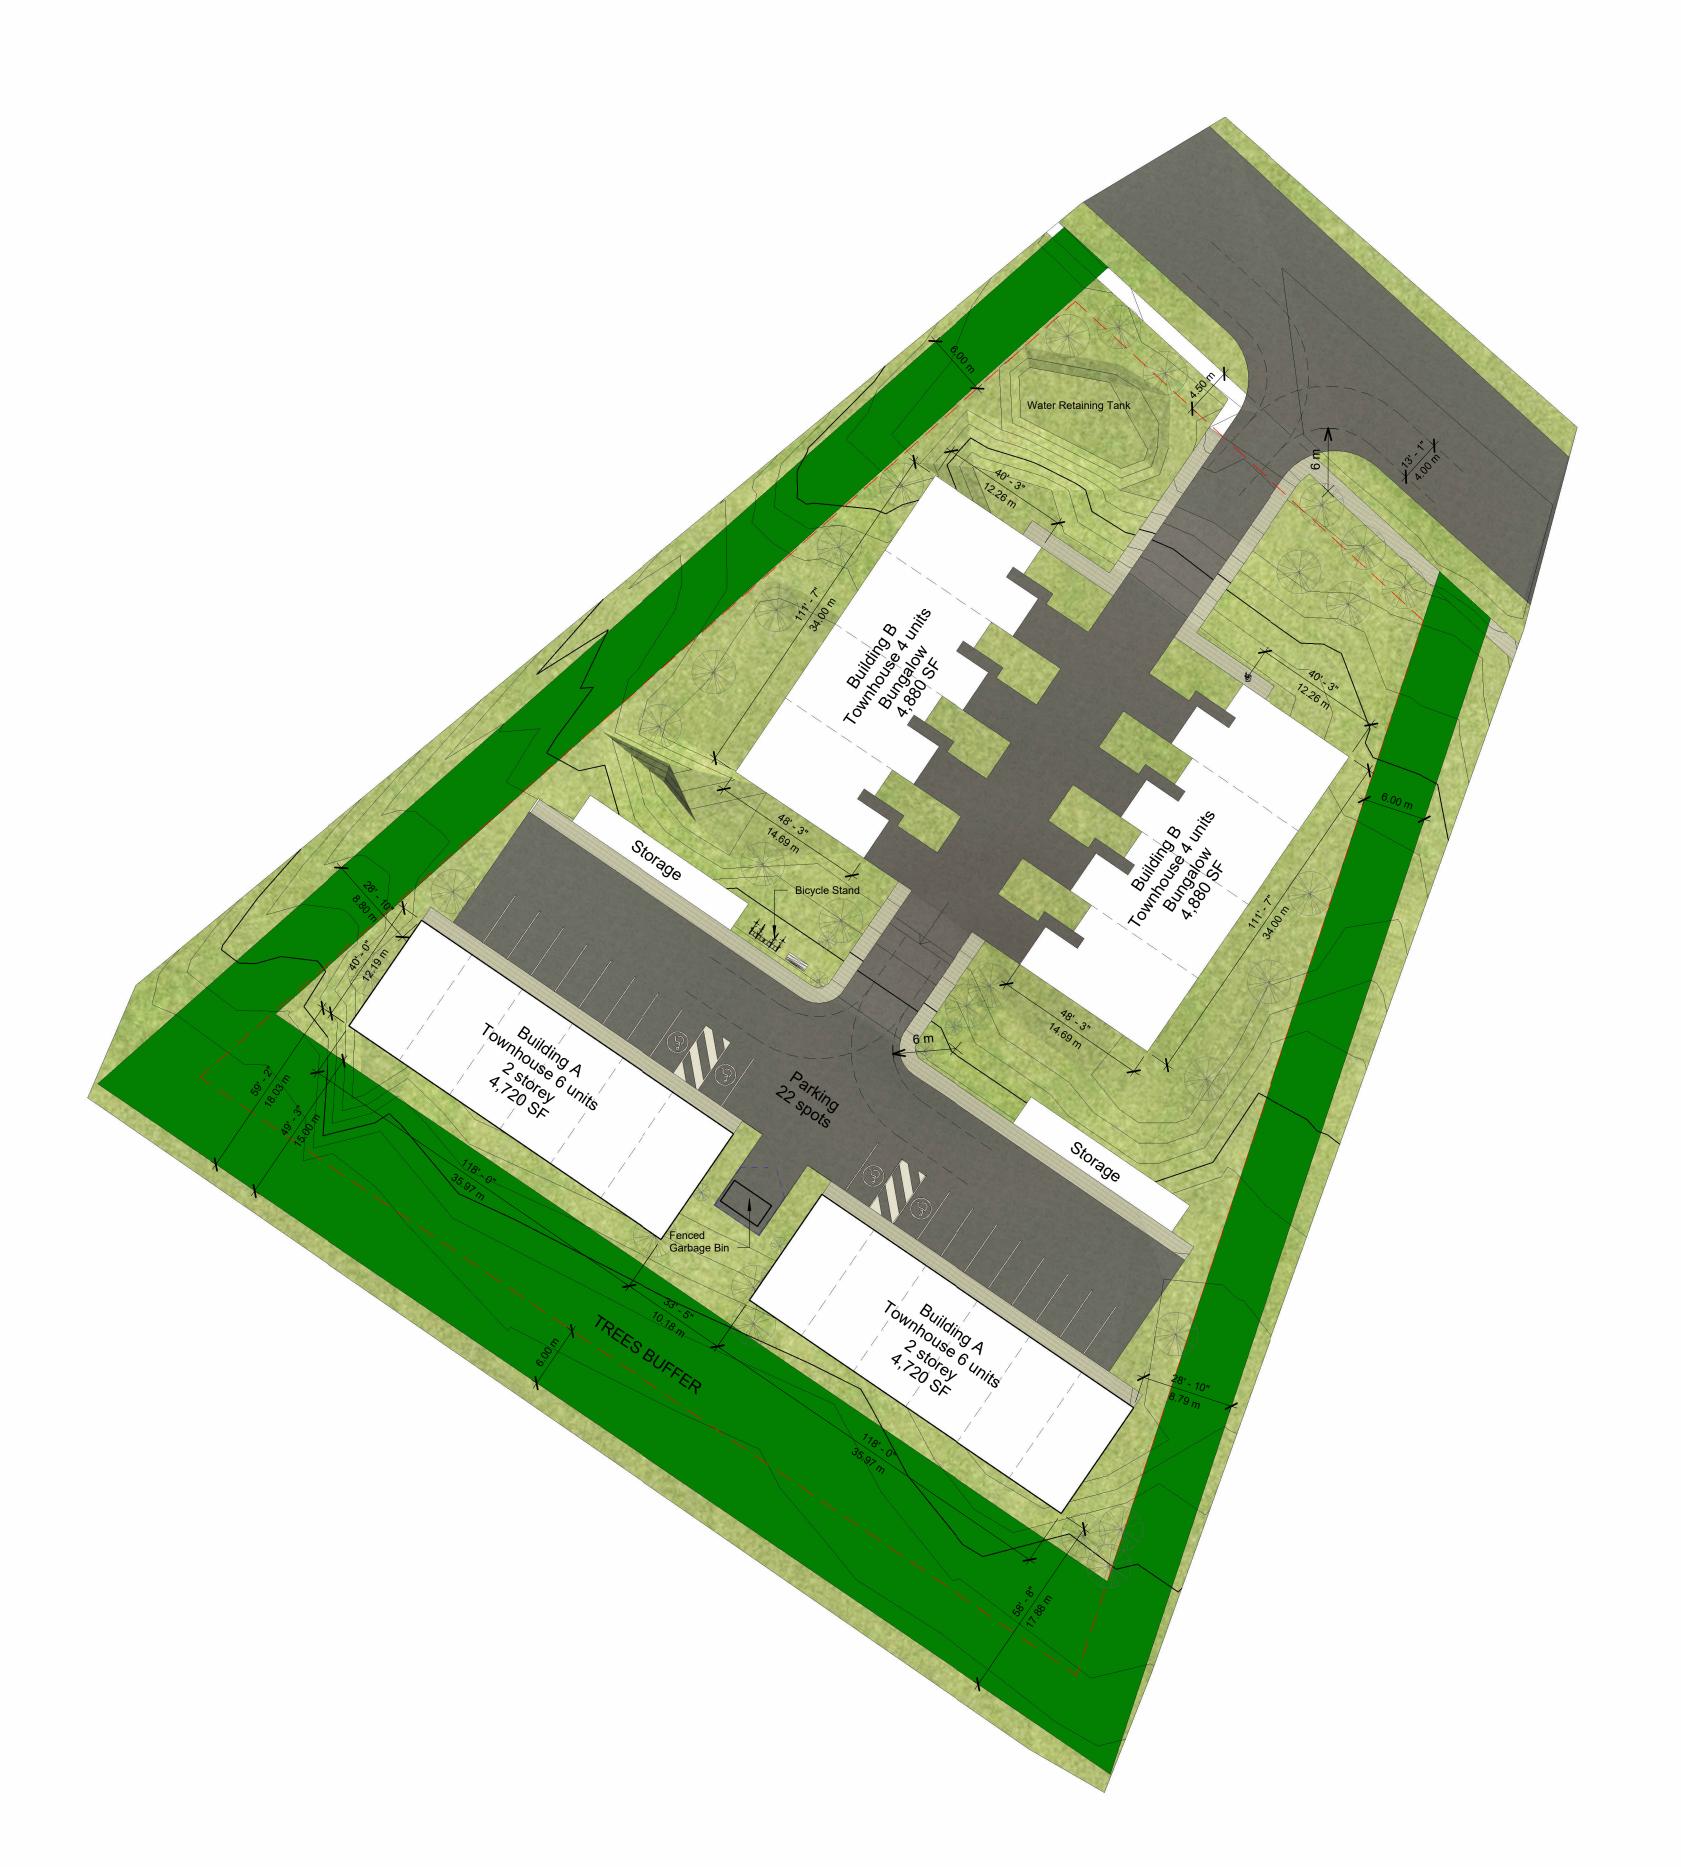Other requirements - Townhouses

Parking Space 2.75 m x 5.50 m (90 degrees)

Parking Lot

Town of Riverview - Zoning By-Law

90 When permitted, townhouse dwellings or rowhouse dwellings shall:

(a) be limited to six dwelling units;(b) despite subsection 90(a), be limited to four dwelling units on a local street, unless a common off street parking lot is provided;

(c) where located on a collector or arterial street, as set out in the Town's Subdivision Development –
Procedures, Standards and Guidelines document, be designed with a common off street parking lot including a two metre wide landscape buffers between the parking lot and property line and have no more than two

(d) have the ground floor building façade, from the established grade to the top of the ground floor, finished with traditional materials that includes at least ten percent brick or masonry material; and (e) be designed so that each dwelling has jogs or recesses of not less than 0.6 metres along the façade of the


1 Site Plan 1" = 30'-0"



Hillsborough Residential Townhouse

PROJECT ADDRESS Hillsborough Road, Route 114 Riverview NB

PROJECT TEAM

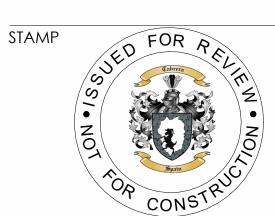

ISSUE SET

Masterplan - Issued for Review


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Site Plan

A100

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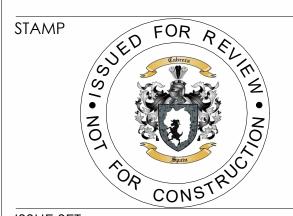




Hillsborough Townhouses Residential-Building B

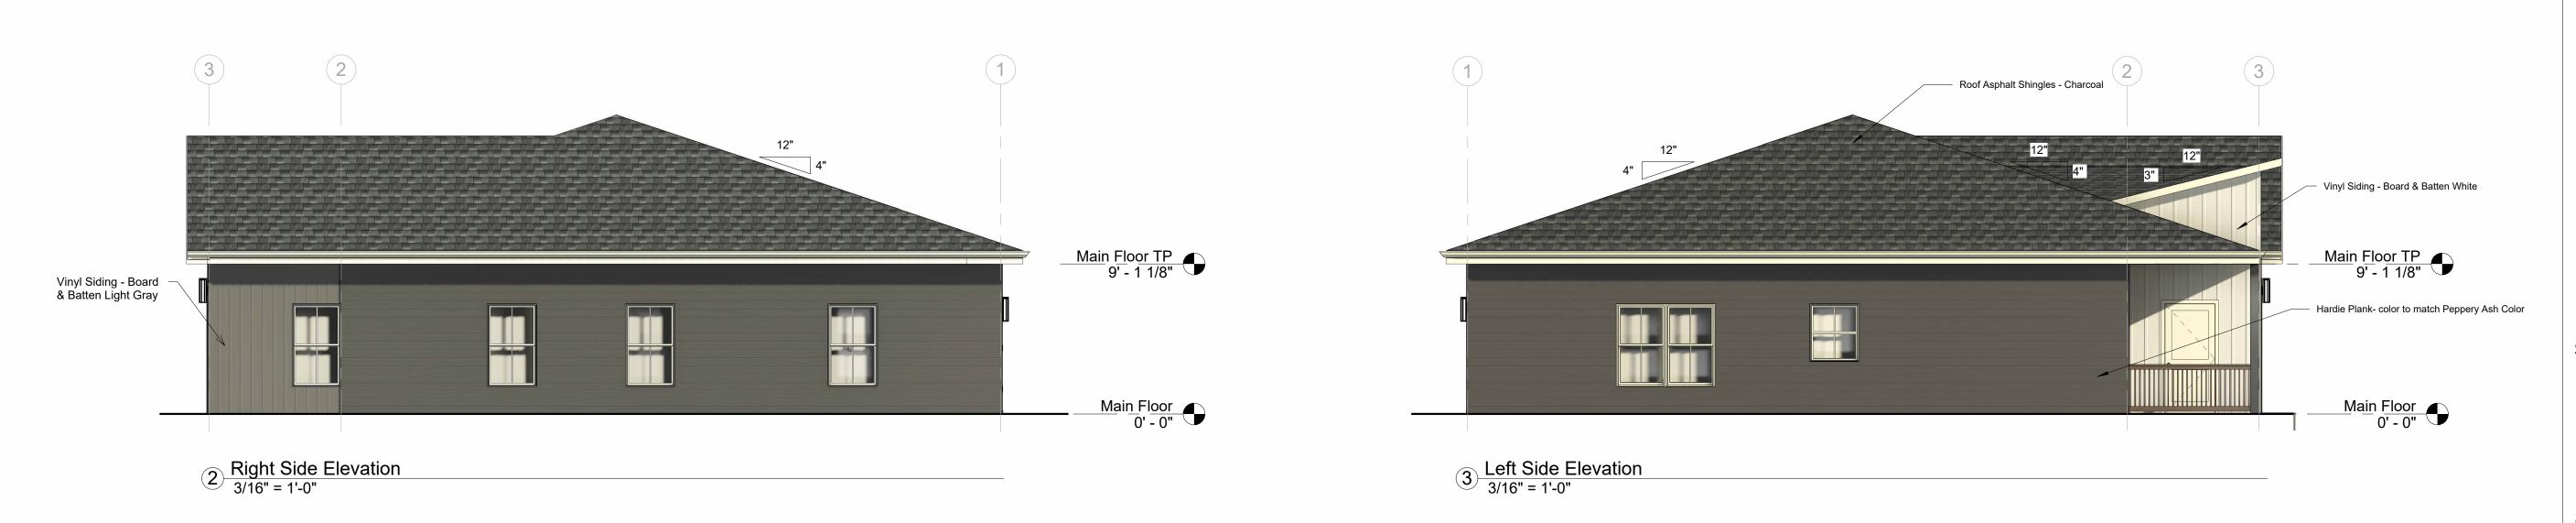PROJECT ADDRESS
Hillsborough Road, Route 114 Riverview, NB

PROJECT TEAM



ISSUE SET

Schematic - Issued for Review


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Building Elevations

A201

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Hillsborough Townhouses ResidentialBuilding B

PROJECT ADDRESS
Hillsborough Road, Route 114 Riverview,
NB

PROJECT TEAM

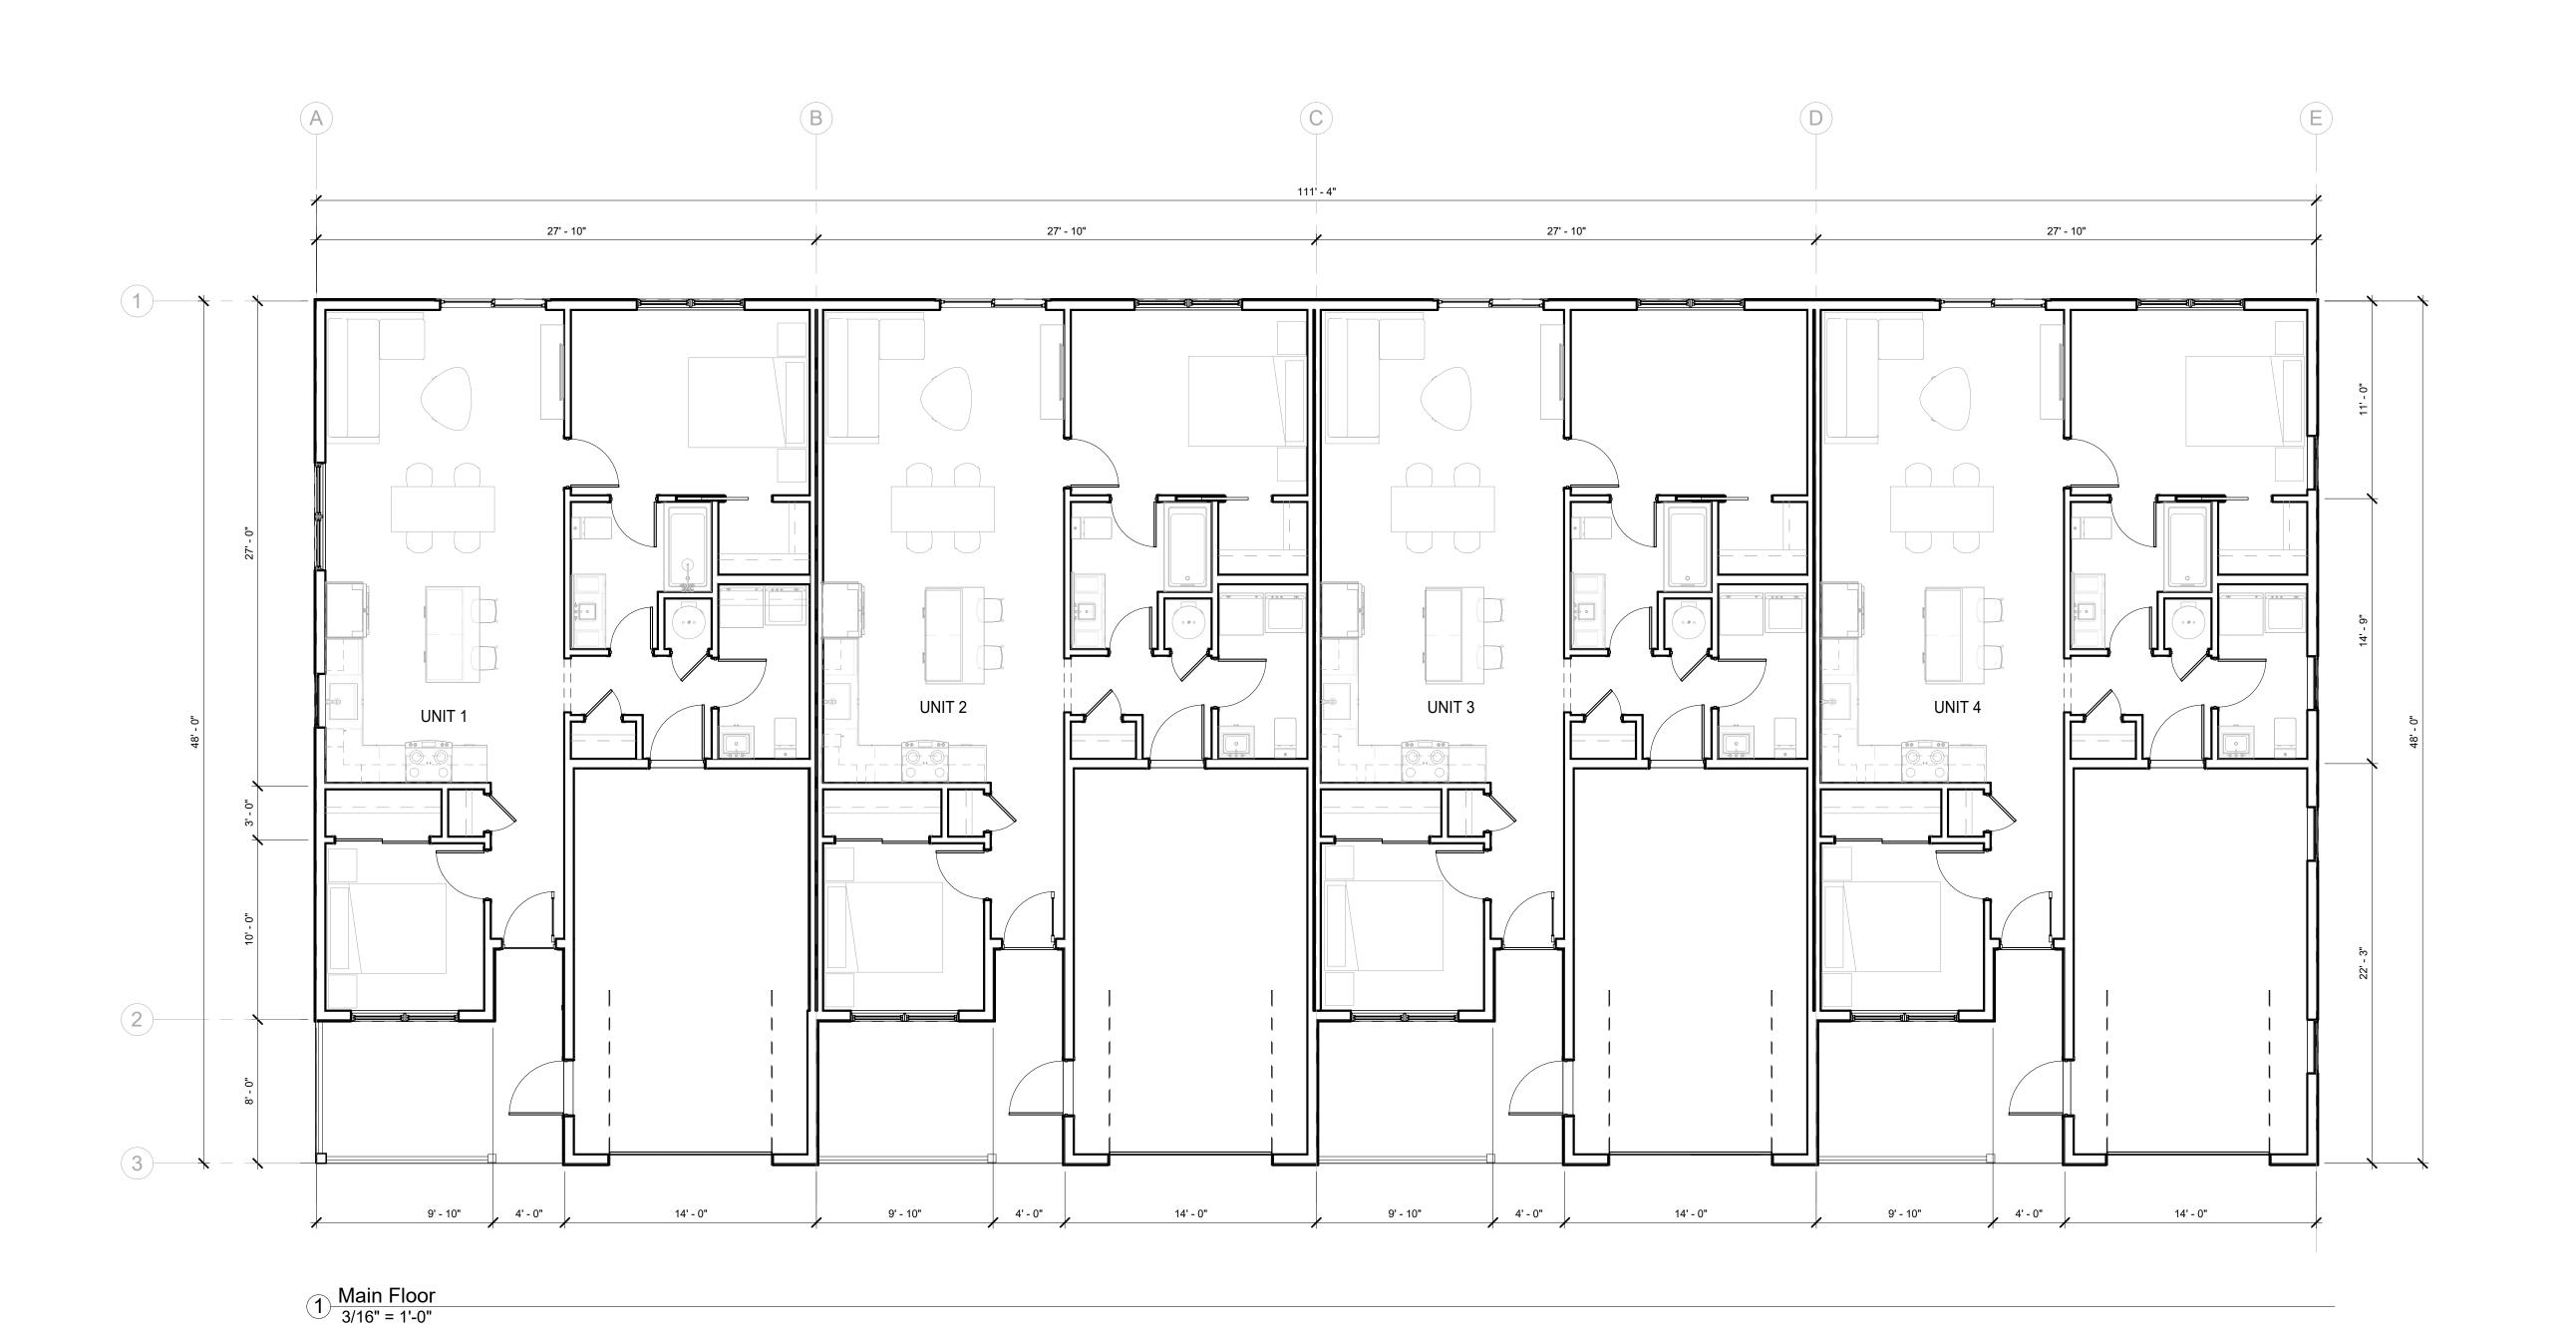

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 22079CANB

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 L. Walter

 CHECKED BY
 A. Cabreira


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Main Floor

A101

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Hillsborough Townhouses Residential-Buildina B

PROJECT ADDRESS
Hillsborough Road, Route 114 Riverview, NB

PROJECT TEAM

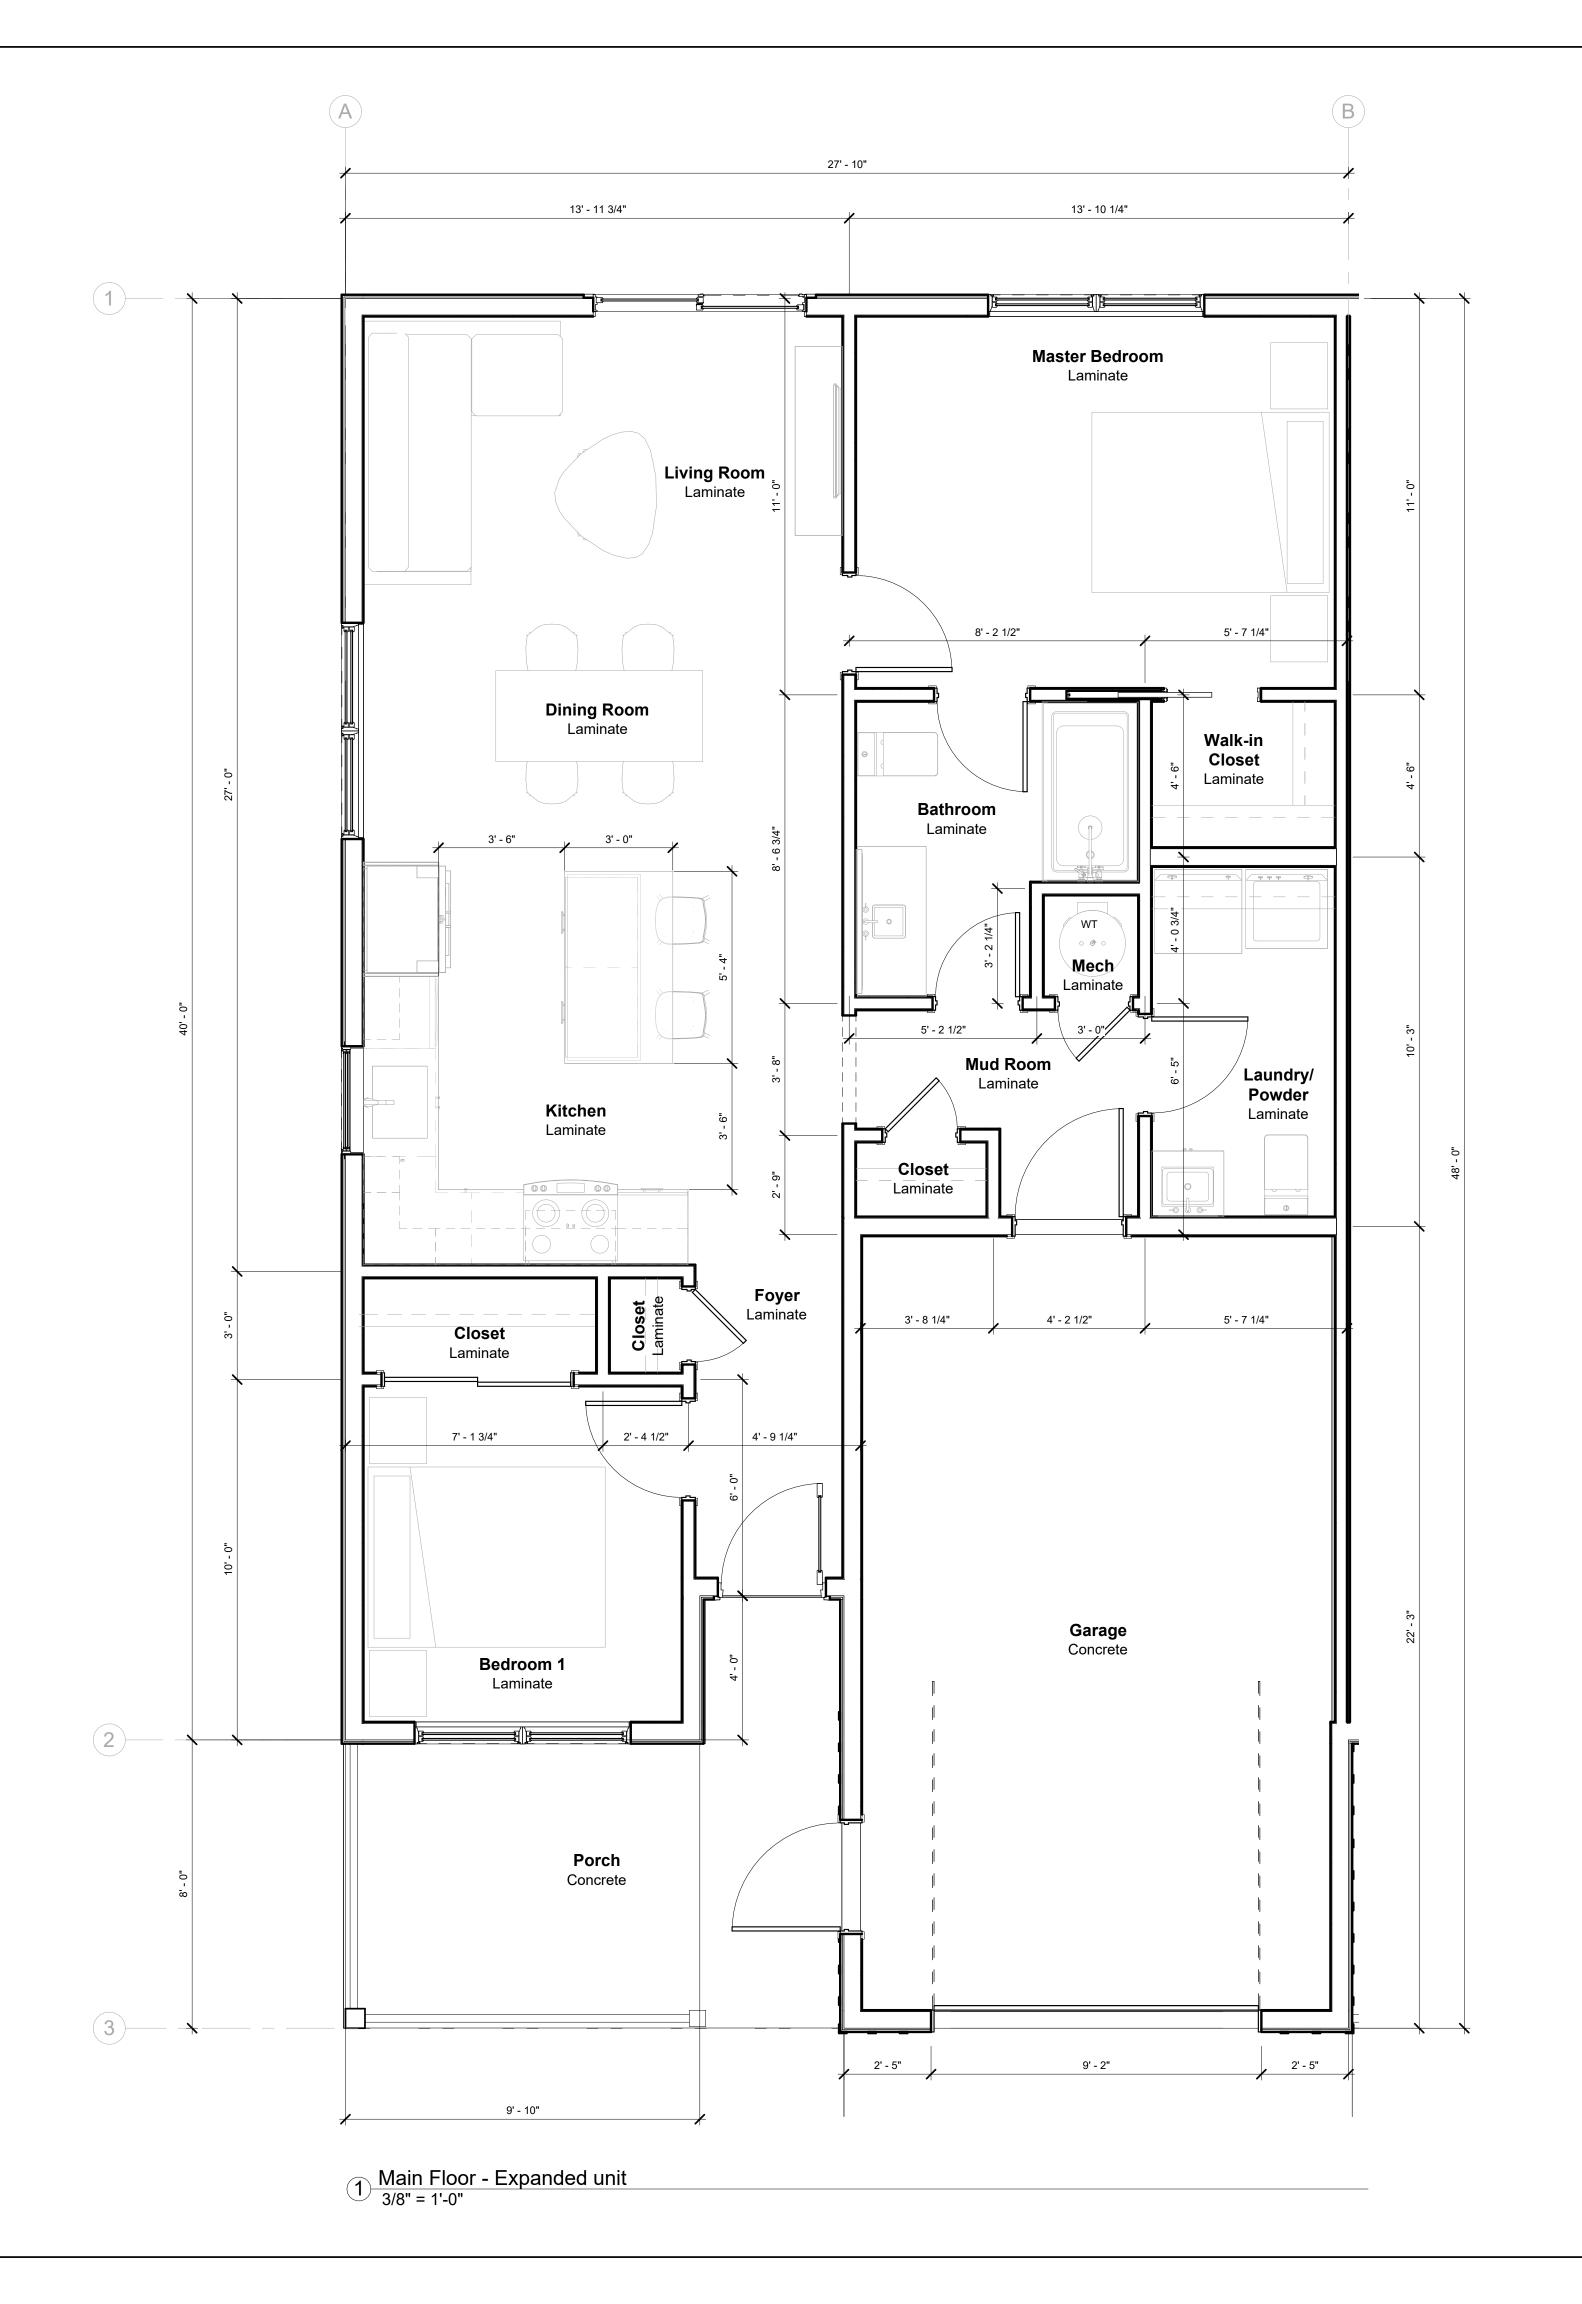

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Main Floor -Expanded unit

A102

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